

CUT & FILL QUANTITY

SOIL CUT VOLUME = 4695.584 CU.M
 SOIL FILL VOLUME = 3166.217 CU.M
 SUBSOIL LEFT FOR DISPOSAL = 1529.367 CU.M
 GRADED LEVEL REFER PLAN AND SECTIONS.


NOTES:

- ALL DIMENSIONS ARE IN METERS UNLESS NOTED OTHERWISE.
- IF IN DOUBT - ASK !!! DO NOT SCALE.
- ALL EXCAVATED TOPSOIL MATERIAL TO BE SPREAD ON SITE TO REMOVE REQUIREMENTS FOR REMOVING FROM SITE.
- ALL WORK TO BE CARRIED OUT IN ACCORDANCE WITH THE RELEVANT BRITISH STANDARDS, CODES OF PRACTICE AND BUILDING PRACTICE.
- ALL DIMENSIONS TO BE CHECKED PRIOR TO STARTING THE WORK ON SITE. ANY DISCREPANCIES TO BE REPORTED TO THE ENGINEER IMMEDIATELY.


LEGEND :

- = Palisade Fence
- = 75mm thick layer of 20-40 mm Granite Chippings
- = 6F5 Recycled Aggregate
- 39.400 = Finished Level
- = Terram T1000 Geotextile Membrane
- = Tensar TX190L Triaxial Geogrid
- = Tree Root Protection Area
- = Tree Canopies

Site Address : Gowerton Solar PV & BESS,
 Swansea Road, Goreinon,
 Swansea, South Wales
Site Postcode: SA4 4LE

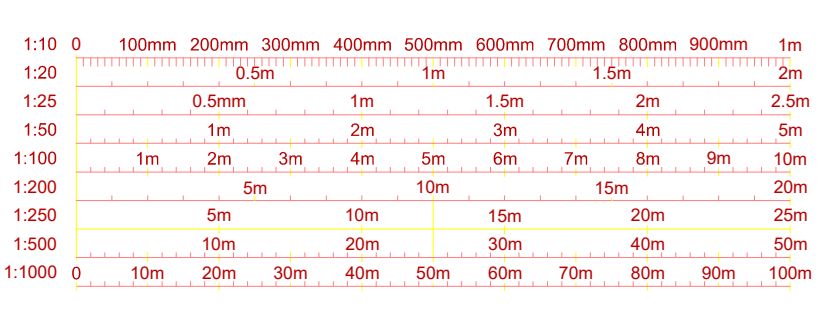

Issue	Date	Purpose of Issue	Drawn	Checked
4.0	23.11.2023	Access Road amended to avoid trees	SR	SF
3.0	23.11.2023	Amended as per revised site plan	SR	SF
2.0	29.10.2023	Amended as per comments	SR	SF
1.0	02.10.2023	For Information	SR	SF

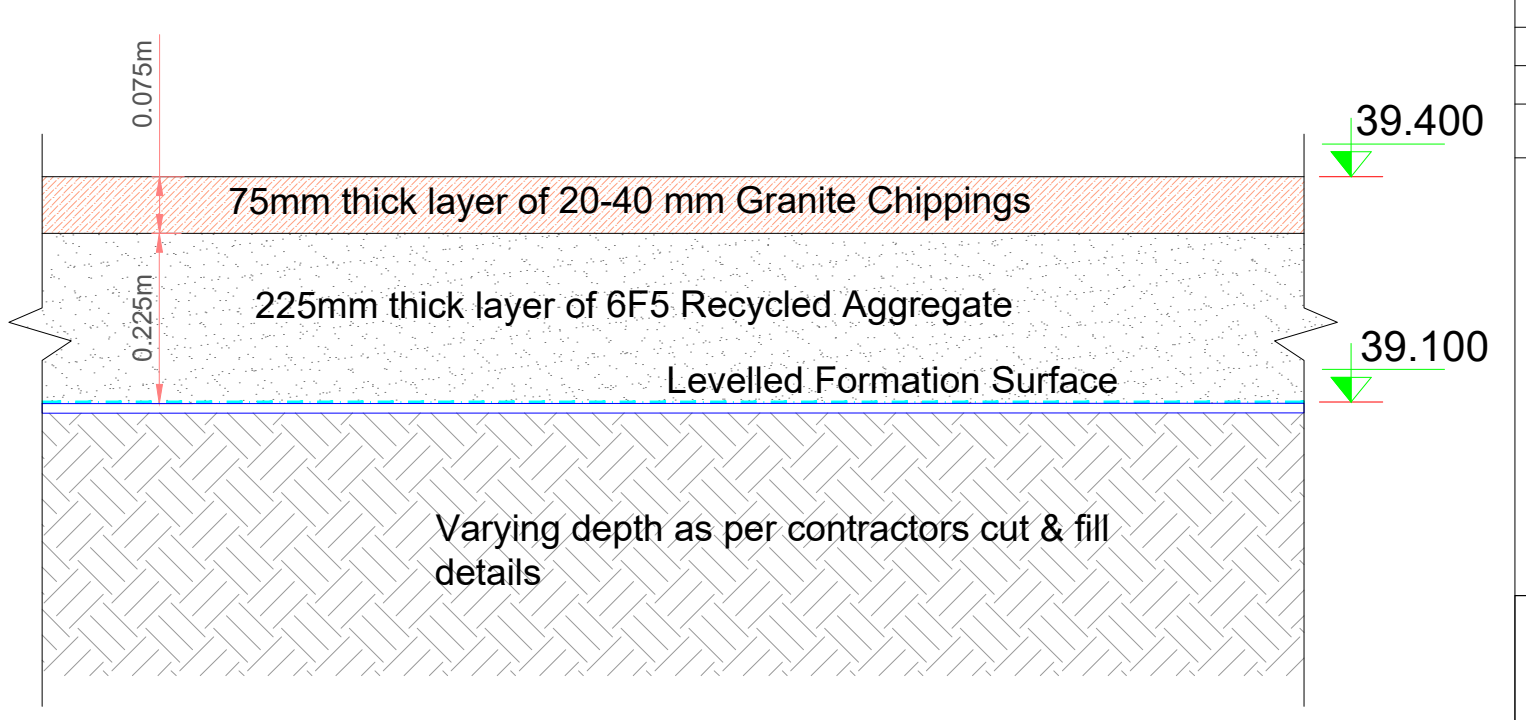

2 TYPICAL SECTION ACROSS SITE
 Scale: NTS



Suite 5, Exchange Station, Tithebarn St, Liverpool, L2 2QP

Client:
 Low Carbon Alliance

Drawing Title:
 Proposed Site Levels

Drawn: SR Date: 02.10.2023 Checked: SF Date: 02.10.2023

Project Title:
 Gowerton
 Job Ref: SC PJ 55 02 Scale: As Shown @ A1

Drawing Number: SC PJ 55 02-150-18 Page Number: 1 of 1 Issue: 4.0

Reference	
Sheet Number	Sheet Name
SC PJ 55 02-150-18	Proposed Site Levels
SC PJ 55 02-150-19	Proposed Site Sections

